



LEGEND & SYMBOLS

- 18 WATTS LED (RECESSED MOUNTED)
CIRCULAR DOWNLIGHT (DAYLIGHT)
- 2-GANG LIGHT SWITCH
- 3-GANG LIGHT SWITCH
- DUPLEX CONVENIENCE OUTLET
- LED TV CONVENIENCE OUTLET
- AIRCONDITIONING UNIT OUTLET
- REFRIGERATOR CONVENIENCE OUTLET
- CIRCUIT NUMBER AND HOMERUN

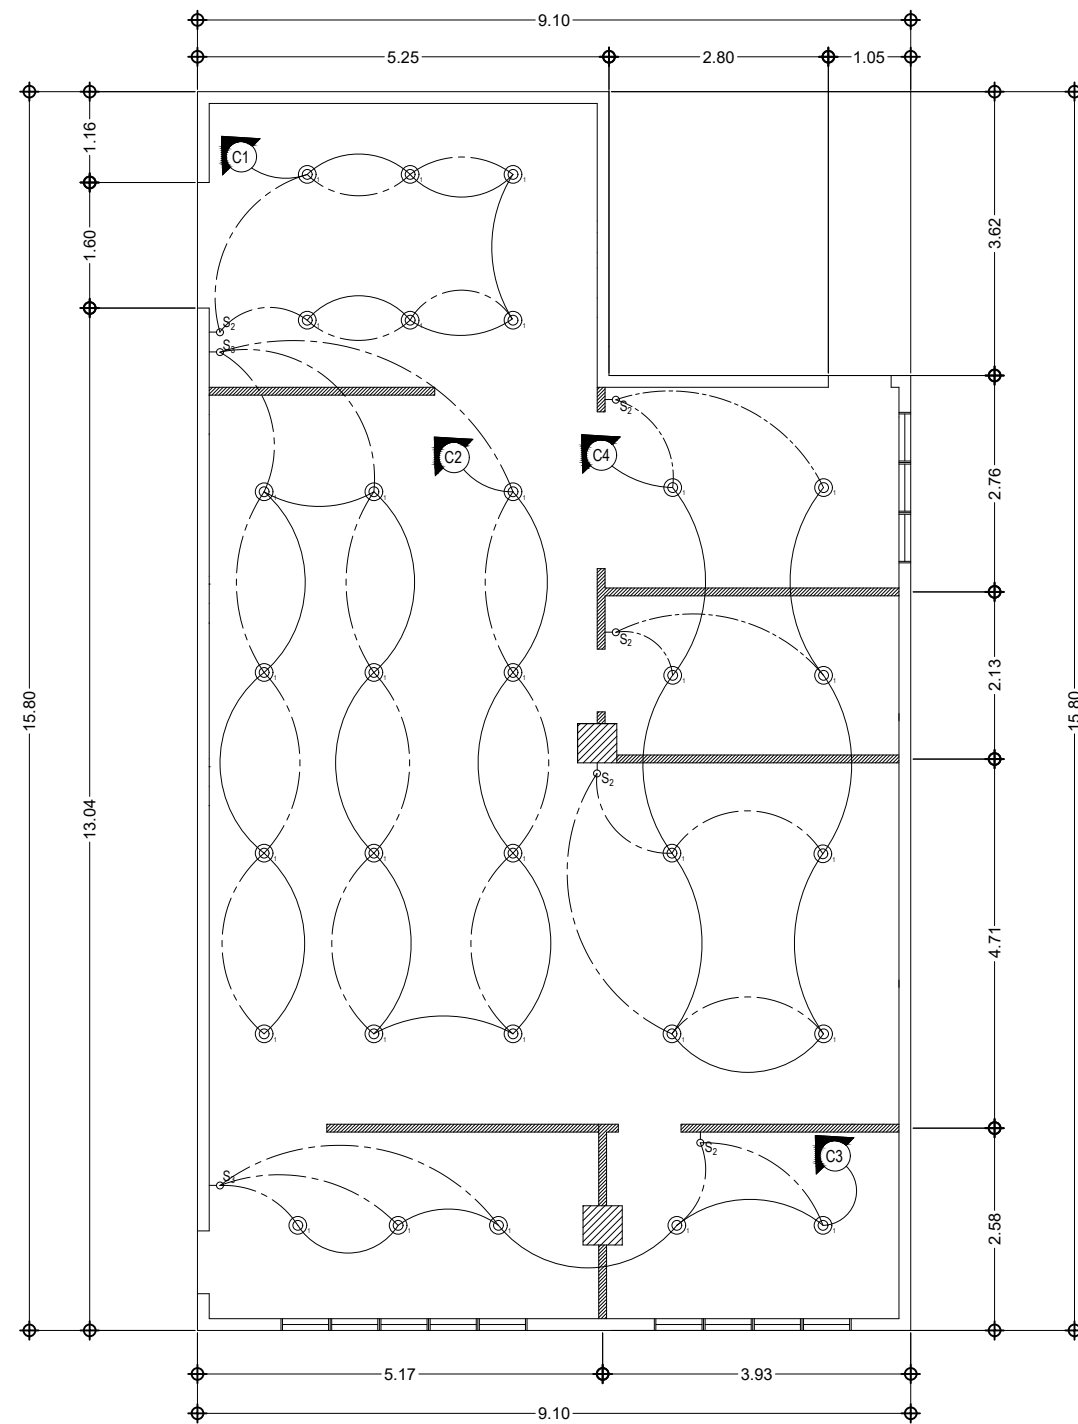

A
E-01 LIGHTING LAYOUT PLAN
SCALE 1 : 20 M.

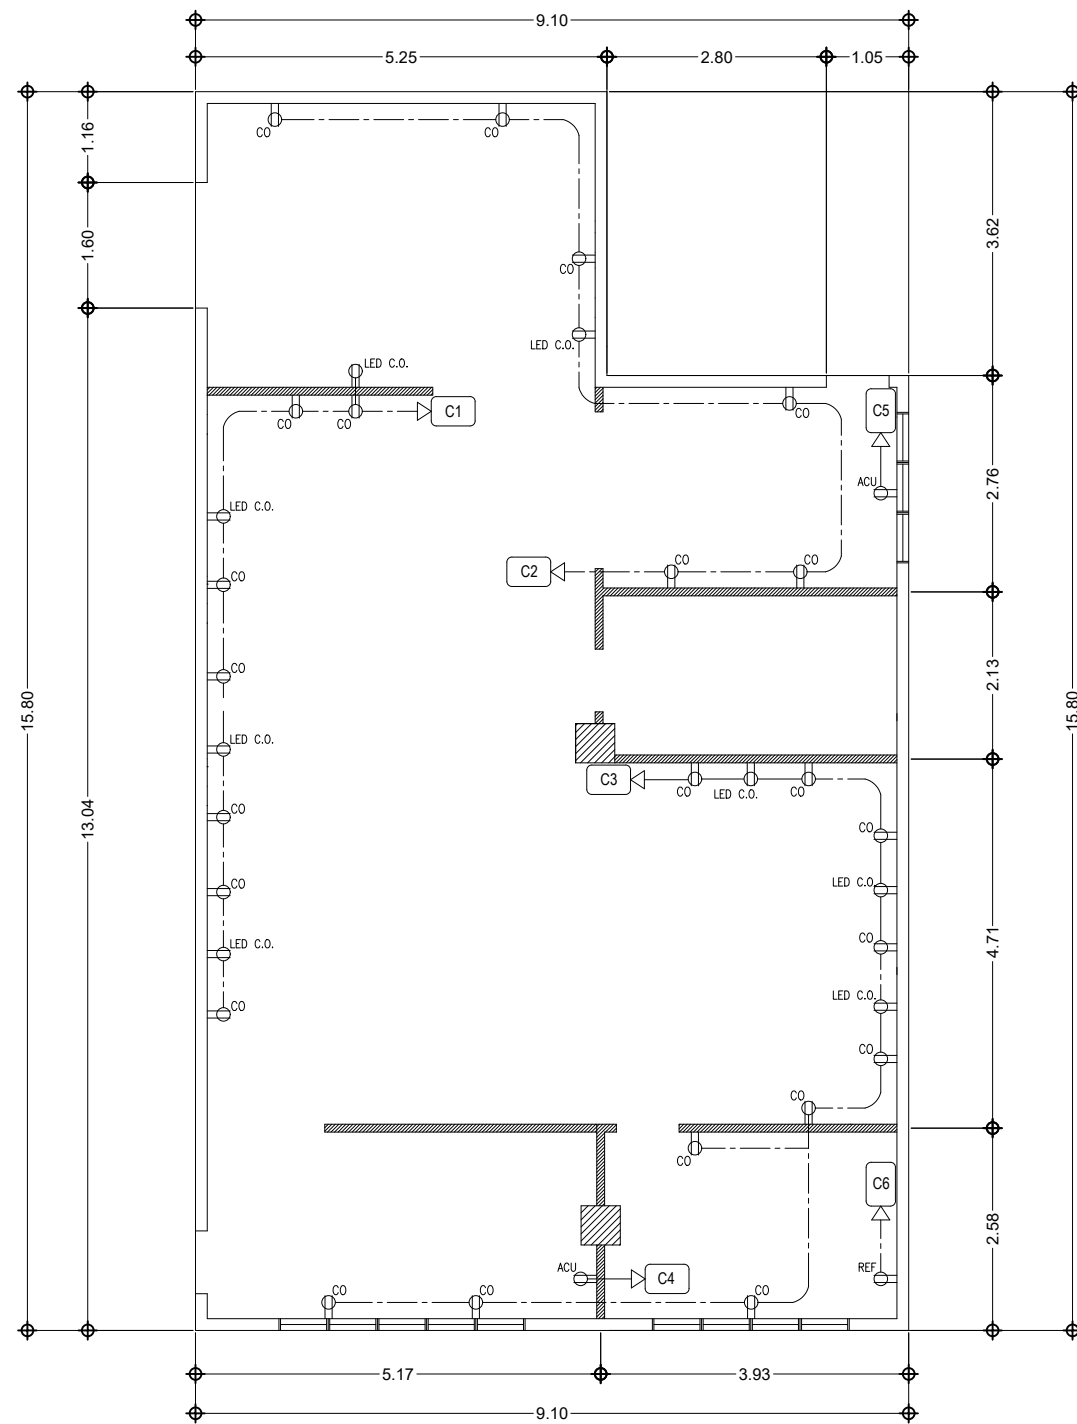

B
E-01 POWER LAYOUT PLAN
SCALE 1 : 20 M.

 SOUTHERN LEYTE STATE UNIVERSITY <small>MAIN CAMPUS San Roque, Tagud, Southern Leyte Contact No. 0998-8685334 Email: president@southernleytestate.edu.ph Website: www.southernleytestate.edu.ph</small>	PREPARED BY :	REVIEWED BY :	PROJECT :	OWNER :	APPROVED AS PER PLAN :	SHEET CONTENT	SHEET NO.
	AR. JEAMES PAUL EVANGELISTA, UAP ARCHITECT I	ENGR. RYAN A. MACUTO, GREEN ADP+AA LUDIP Head Designate	RENOVATION AND RECONFIGURATION OF UISA OFFICE IN ADMIN BUILDING WITH PROVISIONS FOR SMART OFFICE	SOUTHERN LEYTE STATE UNIVERSITY	JUDE A. DUARTE, DPA UNIVERSITY PRESIDENT	AS SHOWN	E-01
<small>Resilience Service Leadership and Good Governance Innovation Social Responsibility Integrity Professionalism Spirituality</small>			LOCATION: SLSU-MAIN CAMPUS, SAN ROQUE, SOGOD SOUTHERN LEYTE	ADDRESS: SOGOD, SOUTHERN LEYTE	CHECKED : DRAWN : APPROVED : DATE :	SCALE AS SHOWN @ 20x30	PROJ. NO.

SCHEDULE OF LOADS

SCHEDULE OF LOADS (LP)

CKT. NO.	DESCRIPTION	POWER(WATTS)	VOLTS	LOAD(AMPERES)			OCPD	CONDUCTOR	CONDUIT
				∅AB	∅BC	∅CA			
1	L.O.(4 LED)	400	220	1.81			15 AT, 50 AF, 2P	2 - 3.5 mm. sq. THHN	13 mm dia. PVC
2	L.O.(12 LED)	1200	220		5.45		15 AT, 50 AF, 2P	2 - 3.5 mm. sq. THHN	13 mm dia. PVC
3	L.O.(5 LED)	500	220			2.27	15 AT, 50 AF, 2P	2 - 3.5 mm. sq. THHN	13 mm dia. PVC
4	L.O.(8 LED)	800	220	3.63			15 AT, 50 AF, 2P	2 - 3.5 mm. sq. THHN	13 mm dia. PVC
5	SPARE								
6	SPARE								
TOTAL				5.44A	5.45A	2.27A			

DEMAND FACTOR 80% AND GROWTH FACTOR 125%

Line Current = 1.732 x 5.45
Line Current = 9.43 A

MAIN PROTECTION	75 AT, 100 AF, 3P
INCOMING FEEDER	3-14mm.sq. THHN +8.0mm.sq.TW(G)
CONDUIT	40mm dia. PVC

SCHEDULE OF LOADS (PP)

CKT. NO.	DESCRIPTION	POWER(WATTS)	VOLTS	LOAD(AMPERES)			OCPD	CONDUCTOR	CONDUIT
				∅AB	∅BC	∅CA			
1	C.O. (11)	2200	220	10.00			20 AT, 50 AF, 2P	2-5.5mm.sq.THHN+2.0mm.sq.TW(G)	20 mm dia. PVC
2	C.O. (7)	1400	220		6.36		20 AT, 50 AF, 2P	2-5.5mm.sq.THHN+2.0mm.sq.TW(G)	20 mm dia. PVC
3	C.O. (13)	2600	220			11.81	20 AT, 50 AF, 2P	2-5.5mm.sq.THHN+2.0mm.sq.TW(G)	20 mm dia. PVC
4	ACU C.O.	1500	220	6.81			20 AT, 50 AF, 2P	2-5.5mm.sq.THHN+2.0mm.sq.TW(G)	20 mm dia. PVC
5	ACU C.O.	1500	220		6.81		20 AT, 50 AF, 2P	2-5.5mm.sq.THHN+2.0mm.sq.TW(G)	20 mm dia. PVC
6	REF C.O.	1500	220			6.81	20 AT, 50 AF, 2P	2-5.5mm.sq.THHN+2.0mm.sq.TW(G)	20 mm dia. PVC
7	SPARE								
8	SPARE								
TOTAL				16.81A	13.17A	18.62A			

DEMAND FACTOR 80% AND GROWTH FACTOR 125%

Line Current = 1.732 x 16.81
Line Current = 29.11 A

MAIN PROTECTION	125 AT, 225 AF, 3P
INCOMING FEEDER	3-30mm.sq. THHN +8.0mm.sq.TW(G)
CONDUIT	40mm dia. PVC


SCHEDULE OF LOADS (DP)

CKT. NO.	DESCRIPTION	POWER(WATTS)	VOLTS	∅AB	∅BC	∅CA	OCPD	CONDUCTOR	CONDUIT
1	L.P.		220	5.44A	5.45A	2.27A	75 AT, 100 AF, 3P	3-14mm.sq. THHN +8.0mm.sq.TW(G)	40mm dia. PVC
2	P.P.		220	16.81A	13.17A	18.62A	125 AT, 225 AF, 3P	3-30mm.sq. THHN +8.0mm.sq.TW(G)	40mm dia. PVC
3	SPARE		220	20A	20A	20A			
4	SPARE		220	20A	20A	20A			
TOTAL				62.25A	58.62A	60.89A			

DEMAND FACTOR 75% AND GROWTH FACTOR 100%





Line Current = 1.732 x 62.25
Line Current = 107.81 A

MAIN PROTECTION	600 AT, 630 AF, 3P, 60Hz, 85 kAIC, MCCB
INCOMING FEEDER	3-200mm.sq. THHN +30mm.sq.TW(G)
CONDUIT	80mm dia. RSC

 <p>SOUTHERN LEYTE STATE UNIVERSITY</p> <p>MAIN CAMPUS San Roque, Tagud, Southern Leyte Contact No. 0998-868-5234 Email: president@southernleyte.edu.ph Website: www.southernleyte.edu.ph</p>	PREPARED BY :	REVIEWED BY :	PROJECT :	OWNER :	APPROVED AS PER PLAN :	SHEET CONTENT	SHEET NO.
	AR. JEAMES PAUL EVANGELISTA, UAP ARCHITECT I	ENGR. RYAN A. MACUTO, GREEN ADP+AA LUDIP Head Designate	RENOVATION AND RECONFIGURATION OF UISA OFFICE IN ADMIN BUILDING WITH PROVISIONS FOR SMART OFFICE	SOUTHERN LEYTE STATE UNIVERSITY	JUDE A. DUARTE, DPA UNIVERSITY PRESIDENT	AS SHOWN	E-02
	LOCATION: SLSU-MAIN CAMPUS, SAN ROQUE, SOGOD SOUTHERN LEYTE			ADDRESS: SOGOD, SOUTHERN LEYTE		CHECKED : DRAWN : APPROVED : DATE :	SCALE AS SHOWN @ 20x30

GENERAL NOTES


1. ALL ELECTRICAL WORKS AND INSTALLATION HEREIN, SHALL BE DONE IN ACCORDANCE WITH THE PROVISION OF THE LATEST EDITION OF THE PHILIPPINE ELECTRICAL CODE, REQUIREMENTS OF THE LOCAL POWER COMPANY, RULES AND REGULATIONS OF THE LOCAL ENFORCING AUTHORITIES.
2. ALL ELECTRICAL WORKS HEREIN SHALL BE EXECUTE BY EXPERIENCED MEN UNDER THE DIRECT SUPERVISION OF DULY REGISTERED MASTER ELECTRICIAN OR ELECTRICAL ENGINEER.
3. THE CONTRACTOR SHALL VERIFY AND ORIENT THE ACTUAL LOCATION OF SERVICE ENTRANCE FOR CONNECTION TO POWER SUPPLY.
4. THE TYPE OF POWER TO BE SUPPLIED SHALL BE, 220VAC, SINGLE PHASE, TWO WIRE PLUS GROUND, 60 HERTZ.
5. UNLESS OTHERWISE SPECIFIED, THE MINIMUM SIZE OF WIRE SHALL BE 3.5 SQMM THHN/THWN AND THE CONDUIT SHALL BE 15 mmØ RSC AND 20 mmØ uPVC.
6. ALL MATERIALS TO BE USED SHALL BE NEW AND OF THE APPROVED TYPE FOR THE LOCATION AND PURPOSE.
7. UNLESS OTHERWISE INDICATE ON THE DRAWING, POLYVINYL CHLORIDE (PVC) CONDUIT SHALL BE USED FOR EMBEDDED WIRING AND RIGID STEEL CONDUIT (RSC) FOR EXPOSED WIRING.
8. ALL WIRE SHALL BE COPPER AND THERMOPLASTIC INSULATED TYPE "THHN/THWN" UNLESS OTHERWISE INDICATED IN THE PLANS. THE MINIMUM SIZE FOR POWER AND LIGHTING SHALL BE 3.5sqmm AND SHALL BE MANUFACTURED BY PHELPS DODGE OR DURAFLEX OR WITH ISO CERTIFICATES.
9. ALL CIRCUIT BOXES SHALL BE GALVANIZED GAGE NO. 16, DEEP TYPE WITH FACTORY KNOCKOUTS .
10. THE CIRCUIT BREAKERS SHALL BE WITH ISO CERTIFICATES AND SHALL BE BOLT-ON TYPE WITH UL LISTED ENCLUSURE.
11. ALL MOUNTING HEIGHTS ARE SUBJECT TO ENGINEER'S APPROVAL PRIOR TO INSTALLATION.
12. PROVIDE GROUND FAULT CIRCUIT INTERRUPTER (GFCI) FOR ALL CONVENIENCE OUTLET LOCATED IN THE LAUNDRY AREA OR IN OUTDOOR USE AS WELL AS IN THE LAVATORY COUNTER AREA.
13. CONDUCT INSULATION RESISTANCE TEST PRIOR FOR TERMINATION OF DEVICES AS WELL AS OTHER NECESSARY ELECTRICAL TESTING STANDARDS.
14. SWITCHES SHALL BE FLUSH MOUNTED AND LOCATED 200mm FROM THE EDGE OF THE DOOR JAMP TO THE CENTER OF THE SWITCH OR 150mm FROM THE EDGE OF THE DOOR JAMP TO THE EDGE OF THE SWITCH.
15. NO REVISION IN THE DESIGN SHALL BE DONE WITHOUT PRIOR KNOWLEDGE AND APPROVAL OF THE DESIGNER.
16. CONTRACTOR WILL PROVIDE THE OWNER WITH TWO(2) SETS OF AS-BUILT PLANS WITH E-FILE AND DULY SIGNED BY THEIR REGISTERED LICENSED ELECTRICAL ENGINEER.

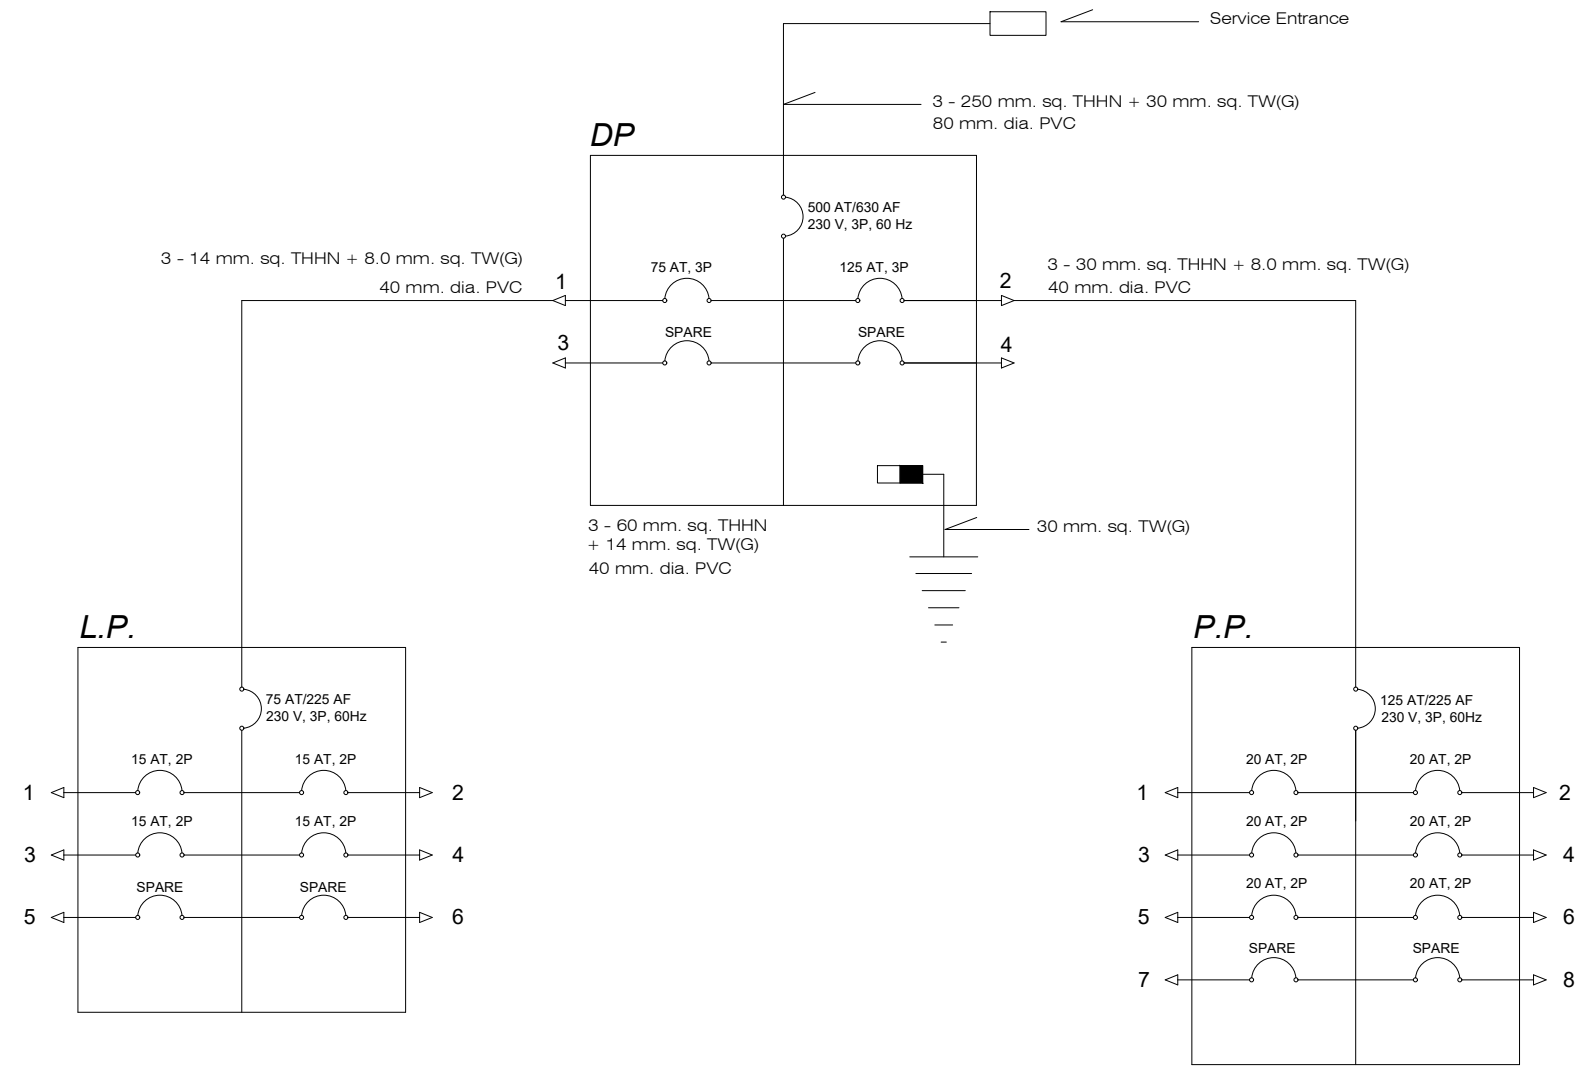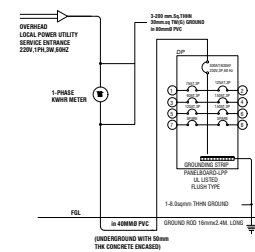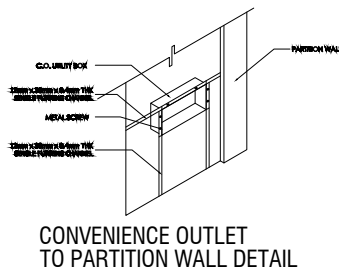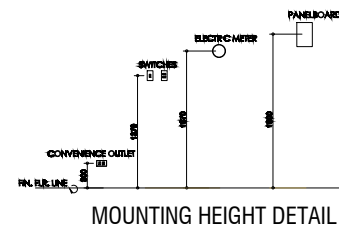

POWER SINGLE LINE DIAGRAM
SCALE N T S.


RISER DIAGRAM
SCALE N T S.

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	LOCATION: SLSU-MAIN CAMPUS, SAN ROQUE, SOGOD SOUTHERN LEYTE	ADDRESS: SOGOD, SOUTHERN LEYTE	CHECKED : APPROVED :	DRAWN : DATE :	SCALE AS SHOWN @ 20x30	PROJ. NO.	

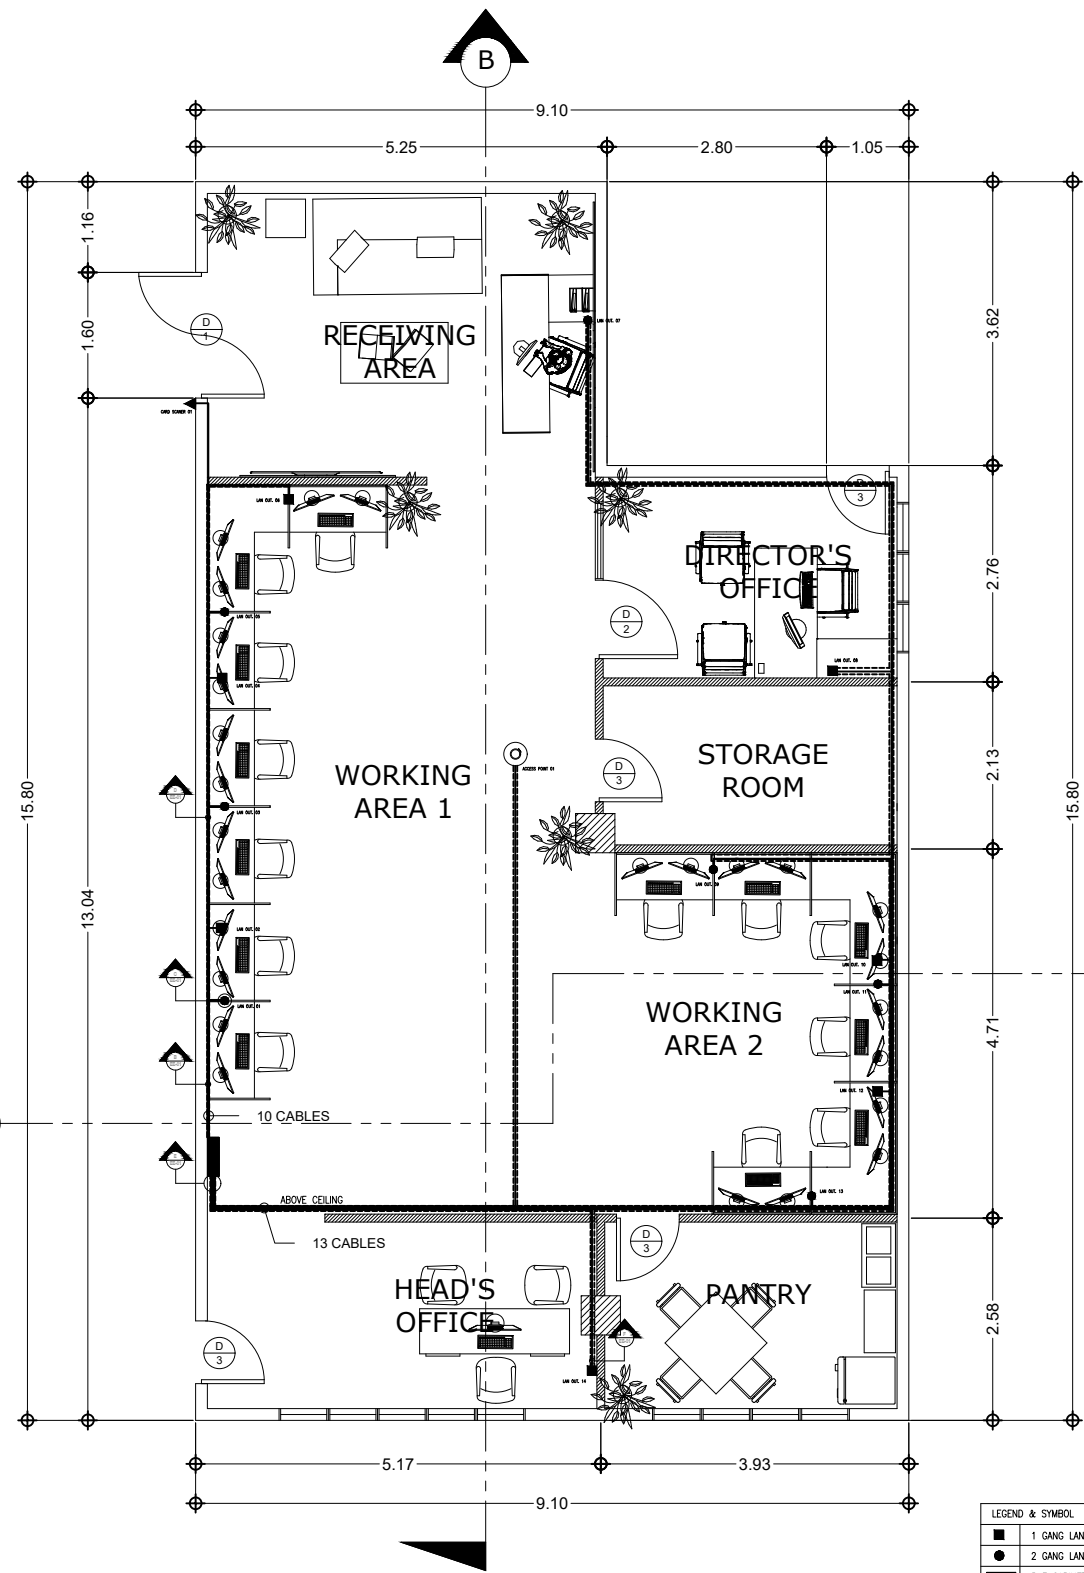


CAT5 CABLING LAYOUT PLAN
 SCALE 1 : 20 M.


LEGEND & SYMBOL	QTY.
1 GANG LAN OUTLET	07
2 GANG LAN OUTLET	07
PoE CABINET	01
CABLE PVC	87 m
CABLE TRAY (PLAN)	21 m
ACCESS POINT	01
CAT6 CABLE	528 m
CARD SCANNER	01

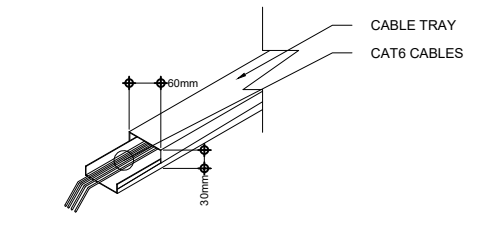


CABLE TRAY DETAILS
 SCALE NTS.

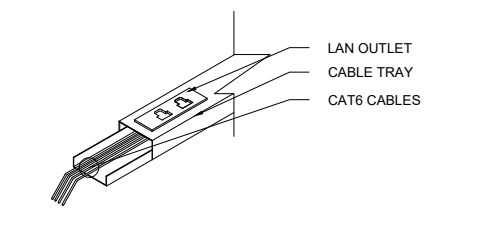


LAN OULET MOUNTING DETAIL
 SCALE NTS.

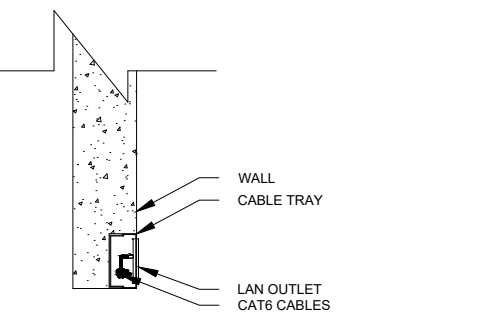


CABLE TRAY MOUNTING DETAIL
 SCALE NTS.

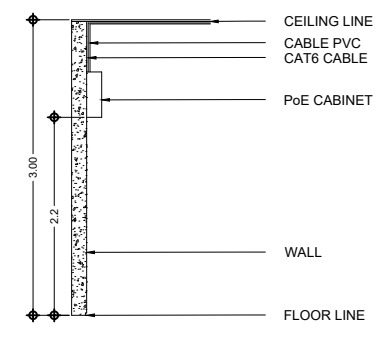

CABLE PVC DETAILS
 SCALE NTS.

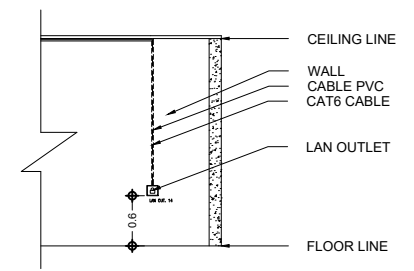


CABLE DROP DETAILS
 SCALE NTS.

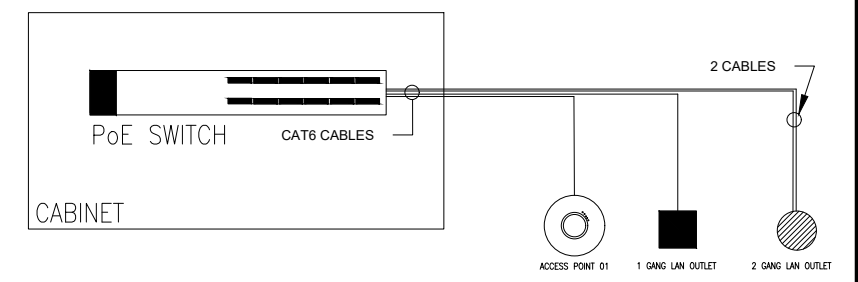

SCHEMATIC DIAGRAM


<p>SOUTHERN LEYTE STATE UNIVERSITY</p> <p>MAIN CAMPUS San Roque, Sogod, Southern Leyte Contact No. 0998-868-5234 Email: president@southernleyte.edu.ph Website: www.southernleyte.edu.ph</p>	PREPARED BY : AR. JEAMES PAUL EVANGELISTA, UAP ARCHITECT I	REVIEWED BY : ENGR. RYAN A. MACUTO, GREENE ADP+AA LUDIP Head Designate	PROJECT : RENOVATION AND RECONFIGURATION OF UISA OFFICE IN ADMIN BUILDING WITH PROVISIONS FOR SMART OFFICE	OWNER : SOUTHERN LEYTE STATE UNIVERSITY	APPROVED AS PER PLAN : JUDE A. DUARTE, DPA UNIVERSITY PRESIDENT	SHEET CONTENT AS SHOWN	SHEET NO. EE-01
	LOCATION: SLSU-MAIN CAMPUS, SAN ROQUE, SOGOD SOUTHERN LEYTE	ADDRESS: SOGOD, SOUTHERN LEYTE	CHECKED : APPROVED :	DRAWN : DATE :	SCALE AS SHOWN @ 20x30	PROJ. NO.	

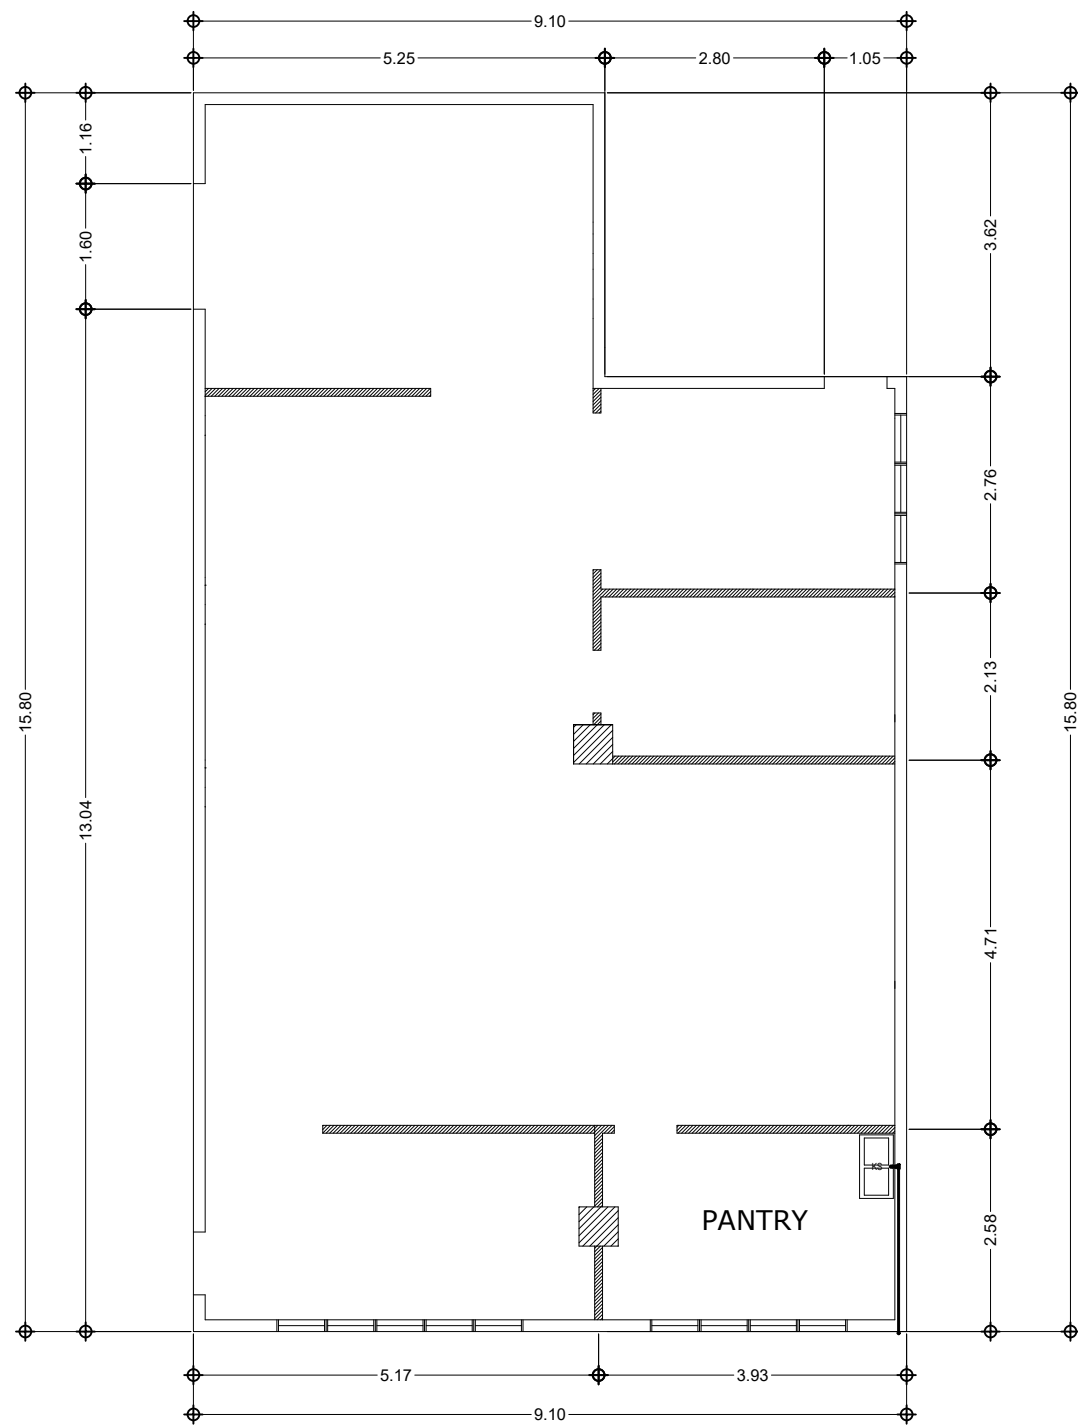

WATER SUPPLY LAYOUT PLAN

A
P-01

SCALE 1 : 20 M.

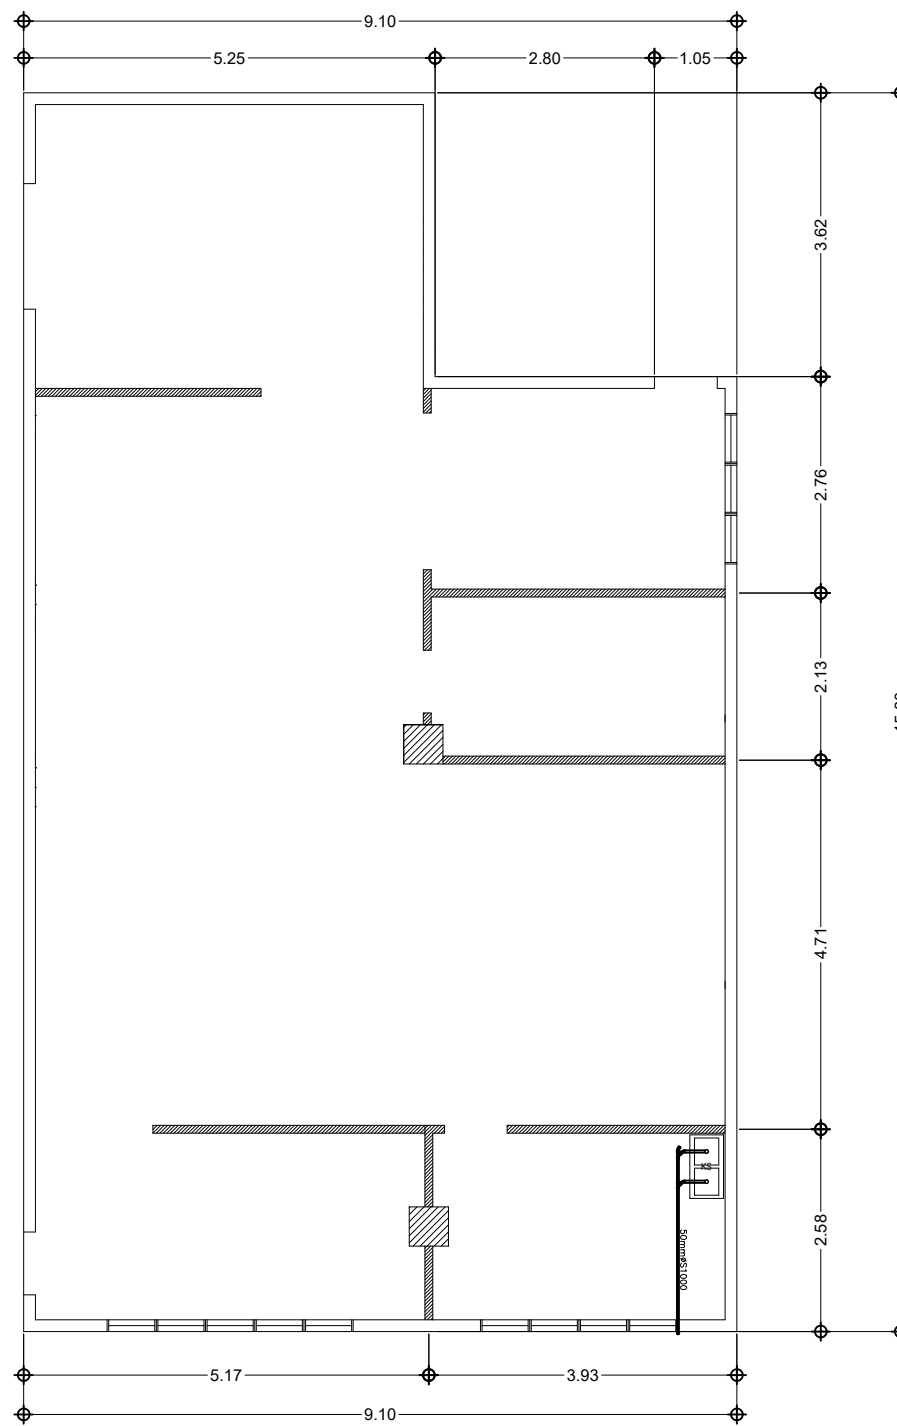

SANITARY LAYOUT PLAN

B
P-01

SCALE 1 : 20 M.

GENERAL NOTES :

1. ALL PLUMBING WORKS HEREIN SHALL BE EXECUTED ACCORDING TO THE PROVISIONS OF THE PHILIPPINE NATIONAL CODE, THE NATIONAL BUILDING CODE AND THE RULES AND REGULATIONS OF THE MUNICIPALITY.
2. COORDINATE THE DRAWINGS WITH OTHER RELATED DRAWINGS AND SPECIFICATIONS.
3. ALL PIPES SHOULD BE INSTALLED AS INDICATED, ANY RELOCATION REQUIRED FOR PROPER EXECUTION OF OTHER TRADES SHALL BE WITH PRIOR APPROVAL OF THE ARCHITECT OR ENGINEER.
4. PROPOSED PLUMBING UTILITIES SHALL CONFORM TO THE ACTUAL LOCATION DEPTH AND ELEVATIONS OF ALL EXISTING PIPES AND STRUCTURES AS VERIFIED BY THE CONTRACTOR.
5. THE PLUMBING CONTRACTOR SHALL VERIFY ALL EXISTING UTILITIES AT THE SITE AND COORDINATE THE WORKS WITH THE SEWER LINE EFFLUENT DISPOSAL POINT AND WATER LINE SERVICE CONNECTING POINT.
6. ALL SLOPES FOR HORIZONTAL DRAINAGE AND SEWER LINE SHALL BE MAINTAINED AT 1% MIN. UNLESS OTHERWISE SPECIFIED.
7. ALL PIPES ARE IN MILLIMETERS AND ALL DIMENSIONS ARE IN METERS UNLESS OTHERWISE SPECIFIED. AND ALL PIPE SIZES FOR WATER LINES INDICATED IN THE PLAN ARE ALL INSIDE DIAMETERS IN MILLIMETERS, UNLESS OTHERWISE SPECIFIED.
8. ALL HOT AND COLD WATER LINES SHALL BE POLYPROPYLENE (PPR) PIPES & FITTINGS, PN 20, "PILSATHERM" PIPES. MADE IN GERMANY, DISTRIBUTED BY MIRAGA TRADE CENTER.
9. DRAWINGS ARE DIAGRAMATIC AND DO NOT SHOW ALL OFFSETS, BENDS, ELBOWS, ETC. WHICH MAY BE REQUIRED FOR PROPER INSTALLATION OF WORKS. SUCH WORK SHALL BE PROVIDED WITH BENDS AND OFFSETS AS NECESSARY AND VERIFIED AT THE SITE.
10. ALL FIXTURES SHALL BE VENTED, UNLESS OTHERWISE INDICATED.
11. BEFORE PERFORMING ANY WORK, CONTRACTOR SHALL THOROUGHLY EXAMINE ALL EXISTING CONDITIONS, POINTS OF CONNECTIONS, SIZES, DEPTHS, LOCATIONS, ETC.

MATERIAL SPECIFICATIONS :

SEWER LINE	POLYVINYL CHLORIDE PIPES AND FITTINGS MANUFACTURED BY "NELTEX" OR ANY APPROVED EQUIVALENT
STORM DRAINAGE LINE	CONCRETE CEMENT PIPES "T & G" FOR OUTSIDE BLDG. AND INSIDE BLDG. SHALL BE PVC PIPES AND FITTING, SERIES 1000 FOR 50mm Ø MANUFACTURED BY "NELTEX" OR ANY APPROVED EQUIVALENT.
COLD WATER LINE	"PILSATHERM" (PPR) PIPES AND FITTINGS PN 20, MADE IN GERMANY
DOWNSPOUTS	POLYVINYL CHLORIDE PIPES AND FITTINGS, SERIES 1000, MANUFACTURED BY "NELTEX" OR ANY APPROVED EQUIVALENT.

NOTES :

1. PROVIDE PIPE SLEEVES, CLAMPS, AND PIPES SADDLES WHERE NECESSARY.
2. REFER TO ARCHITECT FOR WATER PROOFING SPECIFICATIONS.
3. ALL FIXTURES SHALL BE VENTED, UNLESS OTHERWISE INDICATED.
4. REFER TO STRUCTURAL ENGINEER FOR METAL REINFORCING BARS, SLABS, WALL THICKNESS AND OTHER STRUCTURAL DETAILS.

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LOCATION: SLSU-MAIN CAMPUS, SAN ROQUE, SOGOD SOUTHERN LEYTE			ADDRESS: SOGOD, SOUTHERN LEYTE		CHECKED : APPROVED :	DRAWN : DATE :	SCALE AS SHOWN @ 20x30 PROJ. NO.